


SCALE: 1/4" = 1'-0"

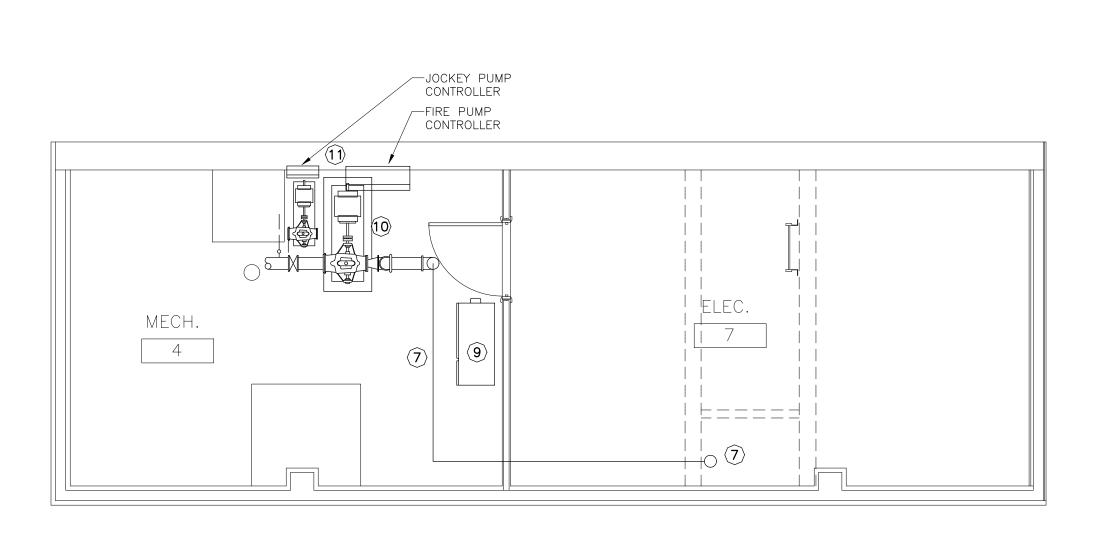

SCALE: 1/4" = 1'-0"

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BASEMENT PLUMBING DEMOLITION PLAN

BASEMENT FIRE PROTECTION DEMOLITION PLAN

DEMOLITION SCOPE

MECHANICAL:

- 1. DEMOLISH AND DISCARD ALL ABANDONED REFRIGERANT LINES IN CHASE. ELECTRICAL:
- 2. DEMOLISH EXISTING ELECTRICAL PANEL. CONDUIT & WIRE TO REMAIN INTACT FOR NEW SERVICE.
- 3. DEMOLISH EXISTING COMMS. PANEL. CONDUIT & WIRE TO REMAIN INTACT FOR NEW SERVICE.
- FIRE PROTECTION:
- 4. DEMOLISH EXISTING SIAMESE FIRE DEPARTMENT CONNECTION (FDC) (HAND OVER TO OWNER). REFURBISH POSITION TO RECEIVE A NEW FDC. 5. DEMOLISH FIRE HOSE CABINET (FHC) (HAND OVER TO OWNER).
- 6. PREPARE EXISTING FHC TO RECEIVE NEW PIPING.
- 7. DEMOLISH ALL FIRE PROTECTION PIPING. REFURBISH EXISTING ROUTE TO RECEIVE NEW PIPING.
- 8. DEMOLISH EXISTING ROOF FIRE HYDRANT VALVE (HAND OVER TO OWNER).
- REFURBISH POSITION TO RECEIVE A NEW FDC. 9. DEMOLISH EXISTING ELECTRICAL PANEL. REFURBISH POSITION TO RECEIVE A NEW FIRE PUMP CONTROLLER.
- 10. DEMOLISH EXISTING FIRE AND JOCKEY PUMPS (HAND OVER TO OWNER). REFURBISH POSITION TO RECEIVE NEW PUMPS.
- 11. DEMOLISH EXISTING FIRE AND JOCKEY PUMPS CONTROLLERS (HAND OVER TO OWNER). MAKE GOOD POSITION. PLUMBING:
- 12. EXISTING INCOMING CITY SUPPLY TO BE UPGRADED TO SCHEDULE 80 PVC PIPE.
- 13. EXISTING WATER SUPPLY TO RESTROOM 33 TO REMAIN FOR RECONNECTION TO NEW WATER DISTRIBUTION. CUT & CAP WATER DISTRIBUTION IN CEILING ABOVE RESTROOM 33.
- 14. EXISTING PRESSURE TANKS, STORAGE TANKS & SEDIMENT FILTER TO REMAIN FOR RECONNECTION.
- 15. DEMOLISH AND DISCARD EXISTING POTABLE & NON-POTABLE PUMPS. COORDINATE WITH INSTALLATION OF NEW PUMPS TO MINIMIZE DISRUPTION OF SERVICE.
- 16. DEMOLISH AND DISCARD MAIN WATER DISTRIBUTION PIPING FROM BASEMENT THRU THIRD FLOOR. COORDINATE WITH INSTALLATION OF NEW MAIN DISTRIBUTION PIPING TO MINIMIZE DISRUPTION OF SERVICE.
- 17. MAINTAIN BRANCH PIPING TO EXISTING PLUMBING FIXTURES IN GROUND AND FIRST FLOOR FOR RECONNECTION. 18. DEMOLISH AND DISCARD ALL EXISTING SEWER AND VENT PIPING TO SECOND
- AND THIRD FLOOR. MAINTAIN EXISTING VENT & SEWER STACK IN FIRST FLOOR CEILING FOR CONNECTION OF NEW SEWER AND VENT PIPING FROM FLOORS ABOVE.

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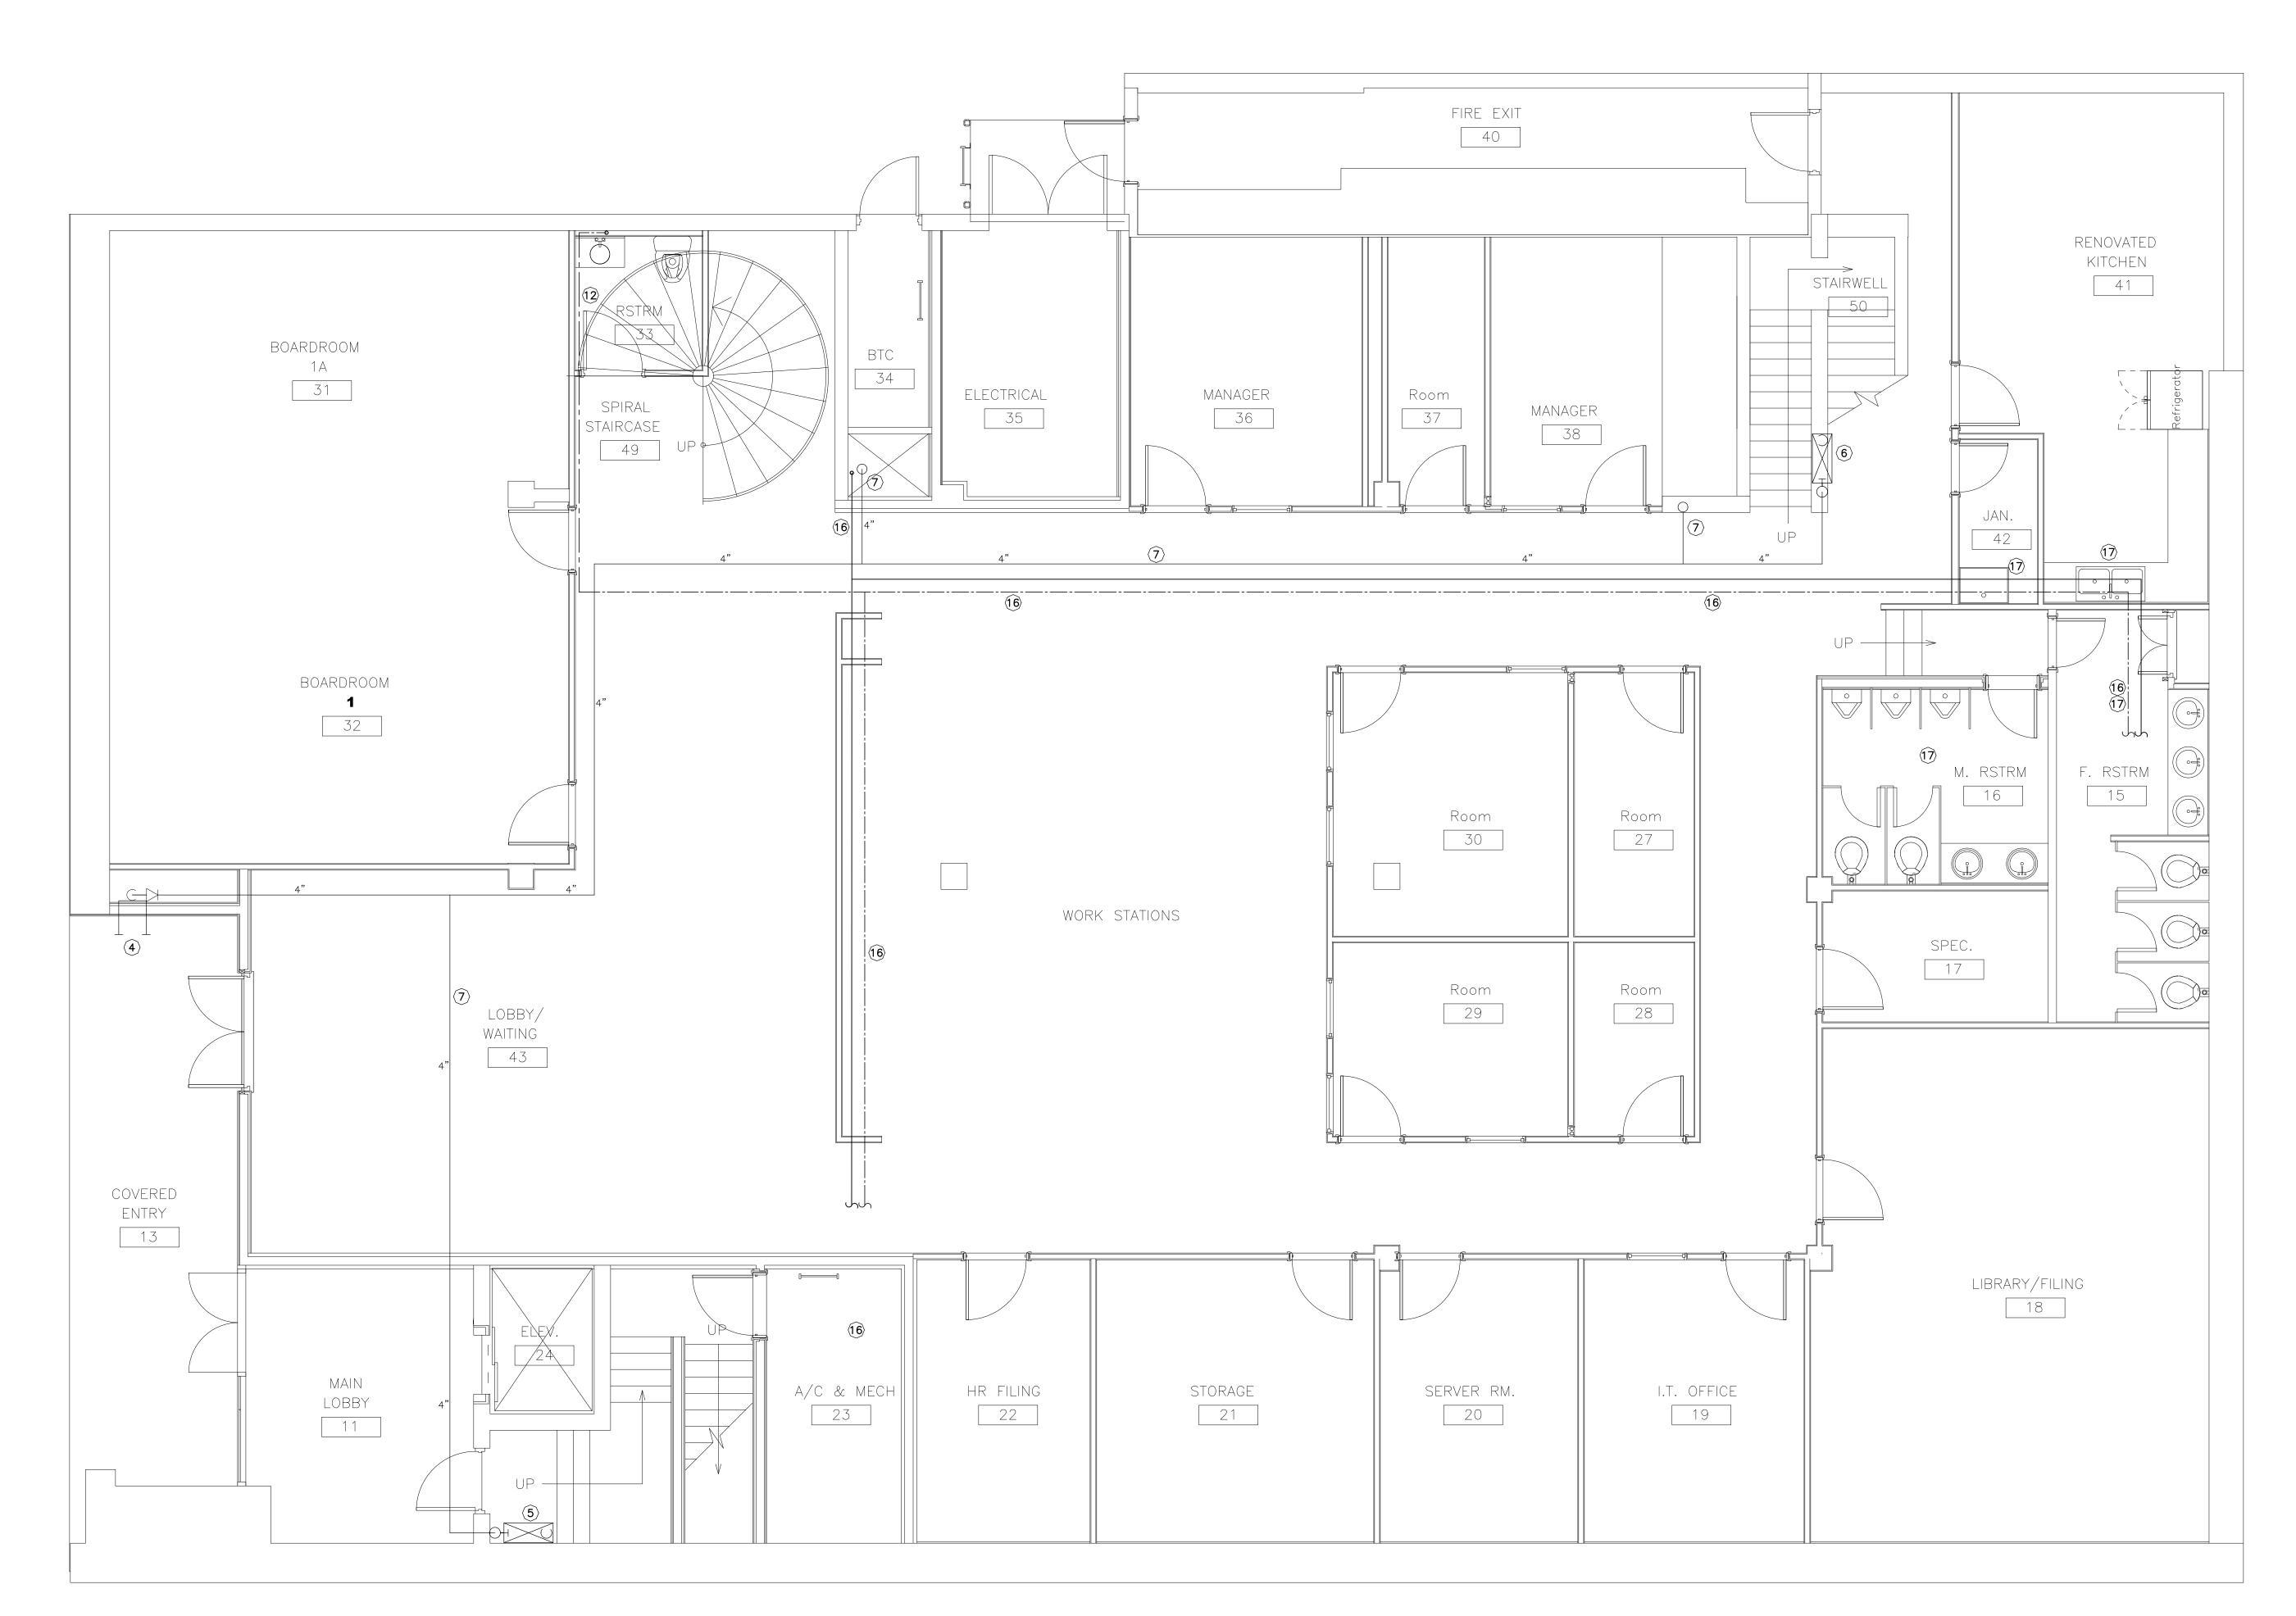


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_____ TITLES _____ SCALE CLIENT _____ PROJECT

06/30/23 DESIGN DEVELOP NO. DATE REVISION	MENT B&A • by		
BROWN & AS + Engineers & Consultants	SSOCIATES , Limited		
PROJECT PROPOSED RENOVATION UTILITIES REGULATION & AUTHORITY – FREDERIC	& COMPETITION		
LOCATION FREDERICK STREET, NASSAU, BAHAMAS.			
TITLES BASEMENT DEMOLITIONSCALE $1/4" = 1'-0"$ CLIENT URCA			
PROJECT ARCHITECT NUMBER	DRAWING NO.		
TDG DRAWN BY B&A DATE OCT.'12	D-1 Ref. \URCA		
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GROUND FLOOR DEMOLITION PLAN SCALE: 1/4" = 1'-0"



DEMOLITION SCOPE

MECHANICAL:


- 1. DEMOLISH AND DISCARD ALL ABANDONED REFRIGERANT LINES IN CHASE. ELECTRICAL:
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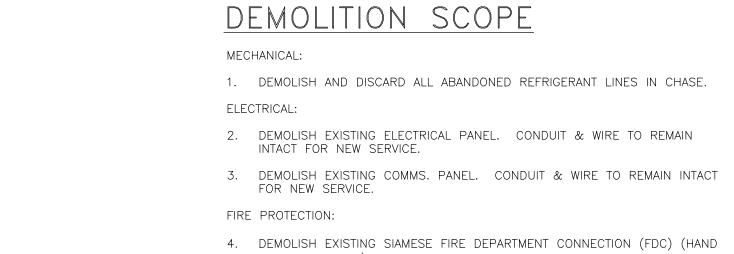
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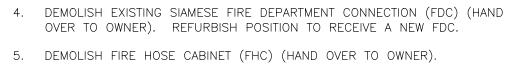
16/30/23 DESIGN DEVELOP No. date revision	MENT B&A
BILLI BROWN & AS	
A Engineers & Consultants	
PROJECT PROPOSED RENOVATION UTILITIES REGULATION &	& COMPETITION
AUTHORITY - FREDERIC LOCATION FREDERICK STREET, NAS	
TITLES GROUND FLOOR DEMO SCALE $1/4" = 1'-0"$	OLITION
CLIENT URCA PROJECT ARCHITECT NUMBER	DRAWING NO.
TDG PROJECT	D-2
date OCT.'12	REF. \URCA



FIRST FLOOR DEMOLITION PLAN SCALE: 1/4" = 1'-0"

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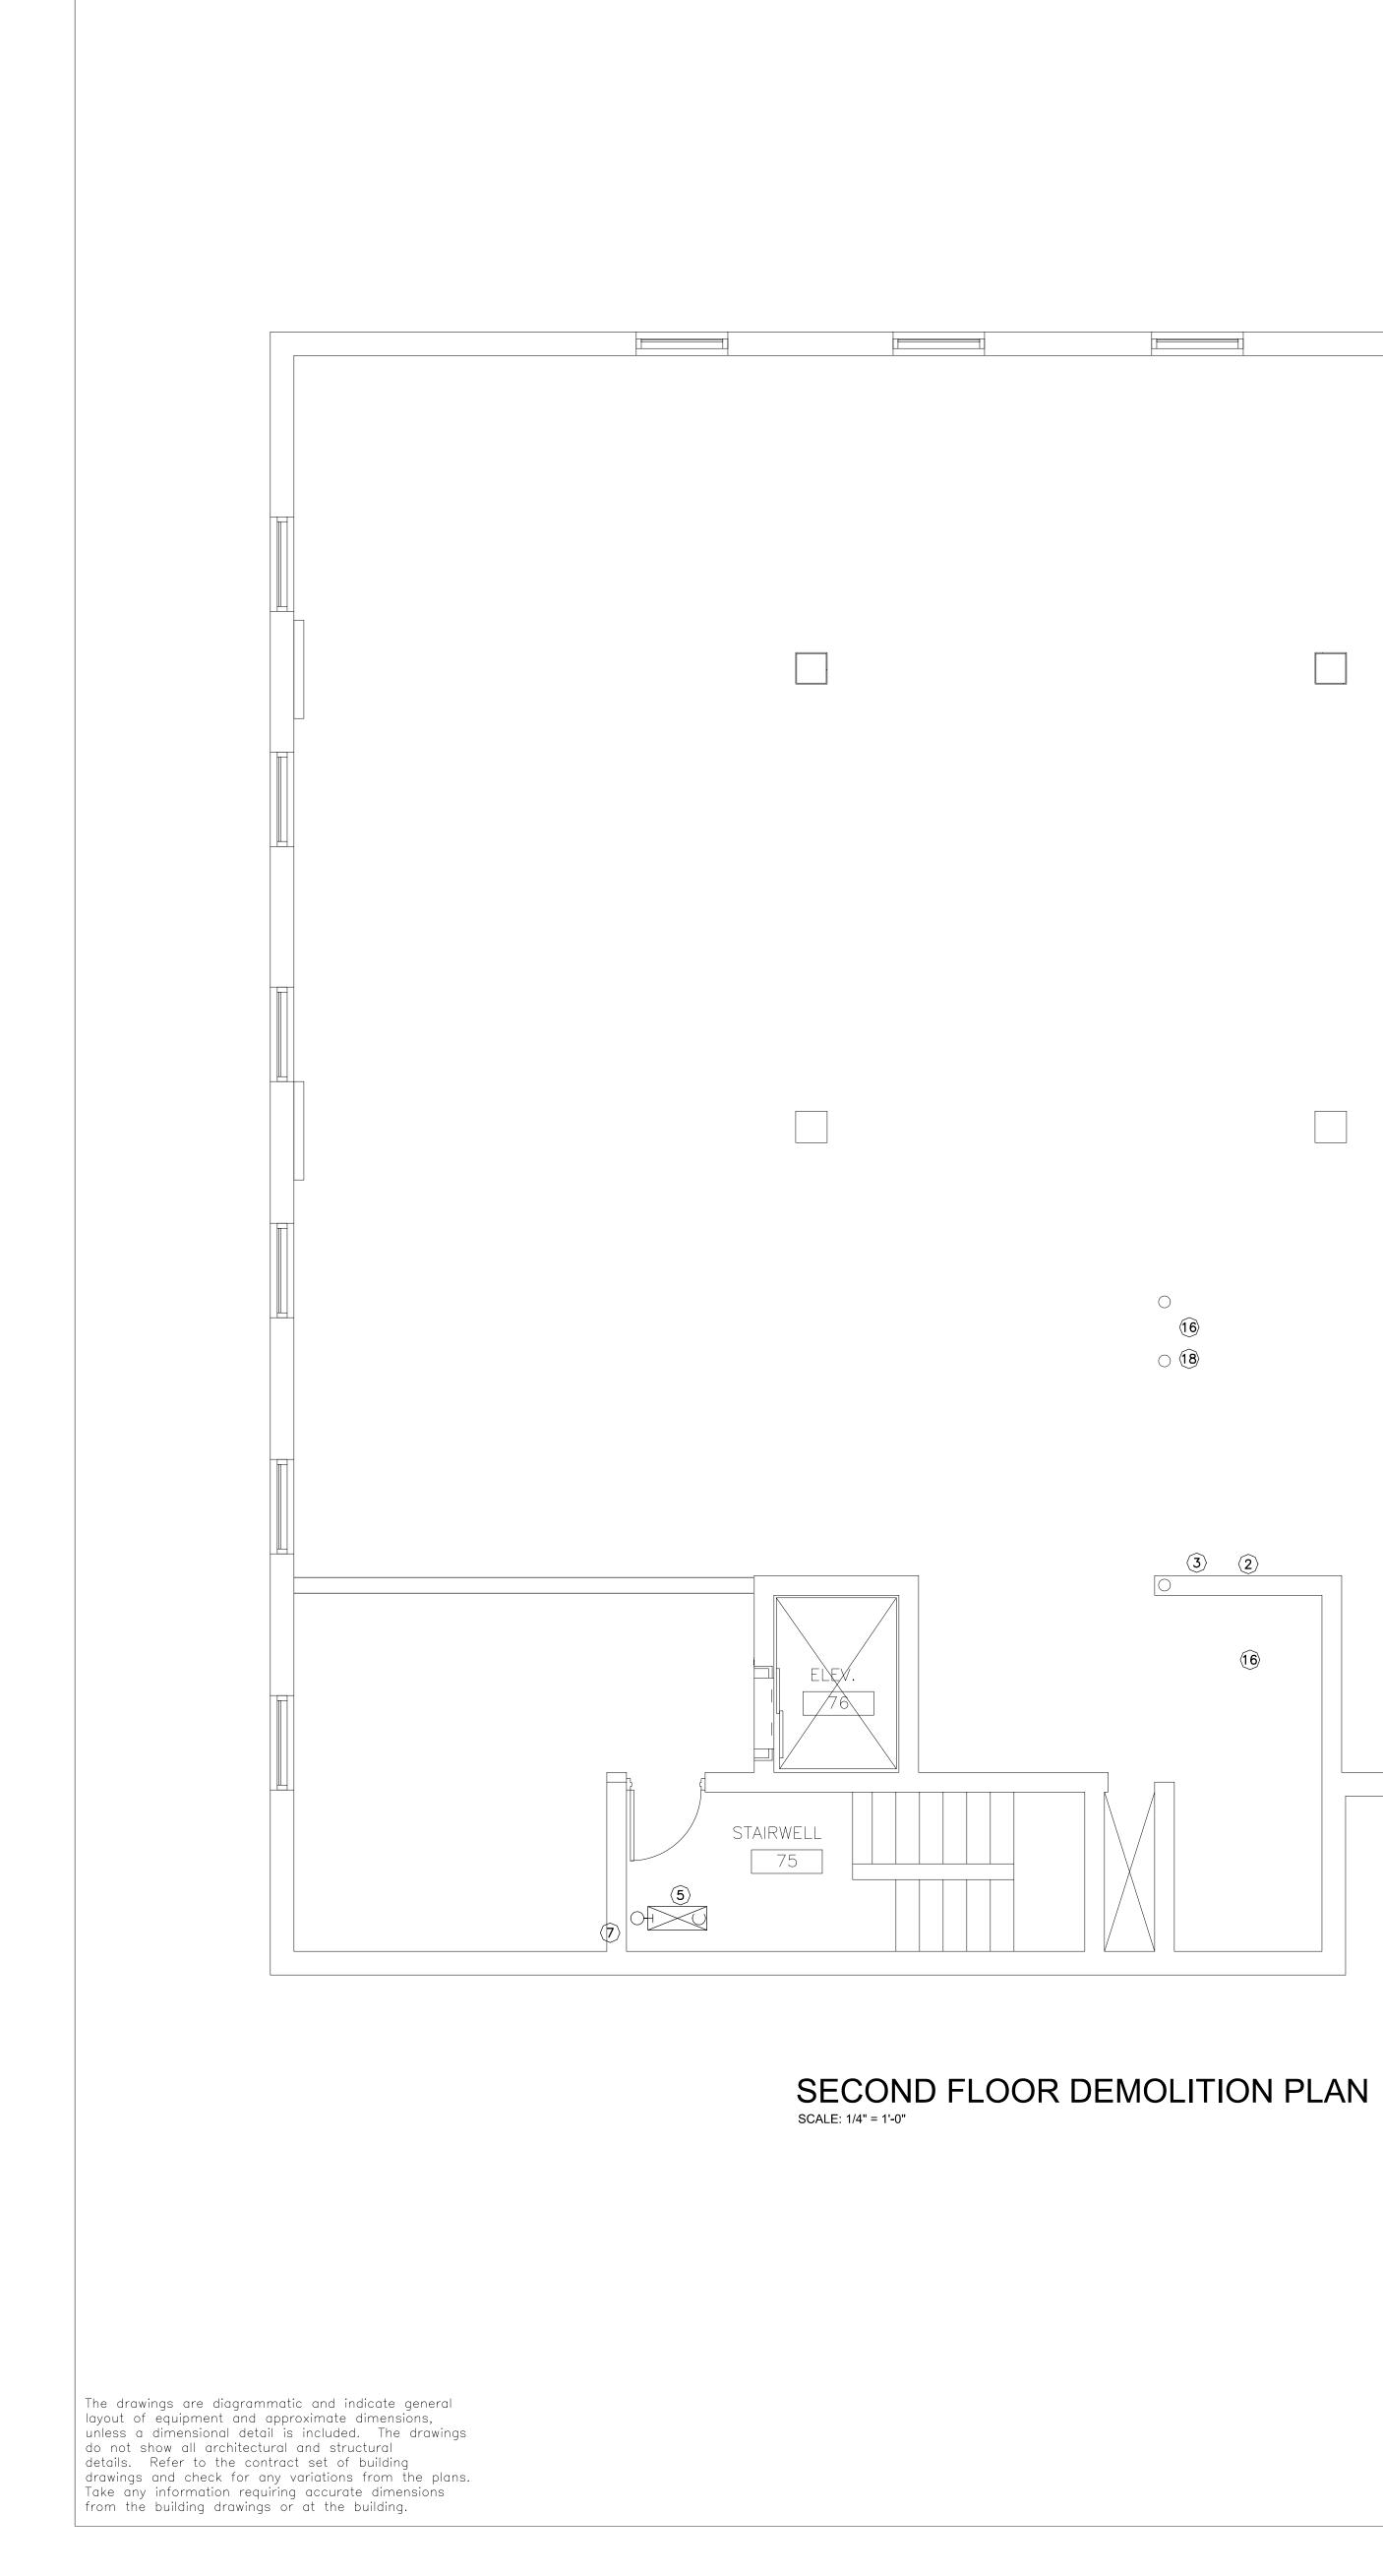


- 6. PREPARE EXISTING FHC TO RECEIVE NEW PIPING.
- 7. DEMOLISH ALL FIRE PROTECTION PIPING. REFURBISH EXISTING ROUTE TO RECEIVE NEW PIPING.
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B + A Engineers & Consultants	SSOCIATES , Limited		
PROJECT PROPOSED RENOVATION UTILITIES REGULATION &	& COMPETITION		
AUTHORITY – FREDERICK HOUSE Location frederick street, nassau, bahamas.			
TITLES FIRST FLOOR DEMOLITION SCALE $1/4" = 1'-0"$			
CLIENT URCA			
PROJECT ARCHITECT NUMBER TDG DRAWN BY B&A	drawing no. $D-3$		
DATE OCT.'12	REF. URCA		

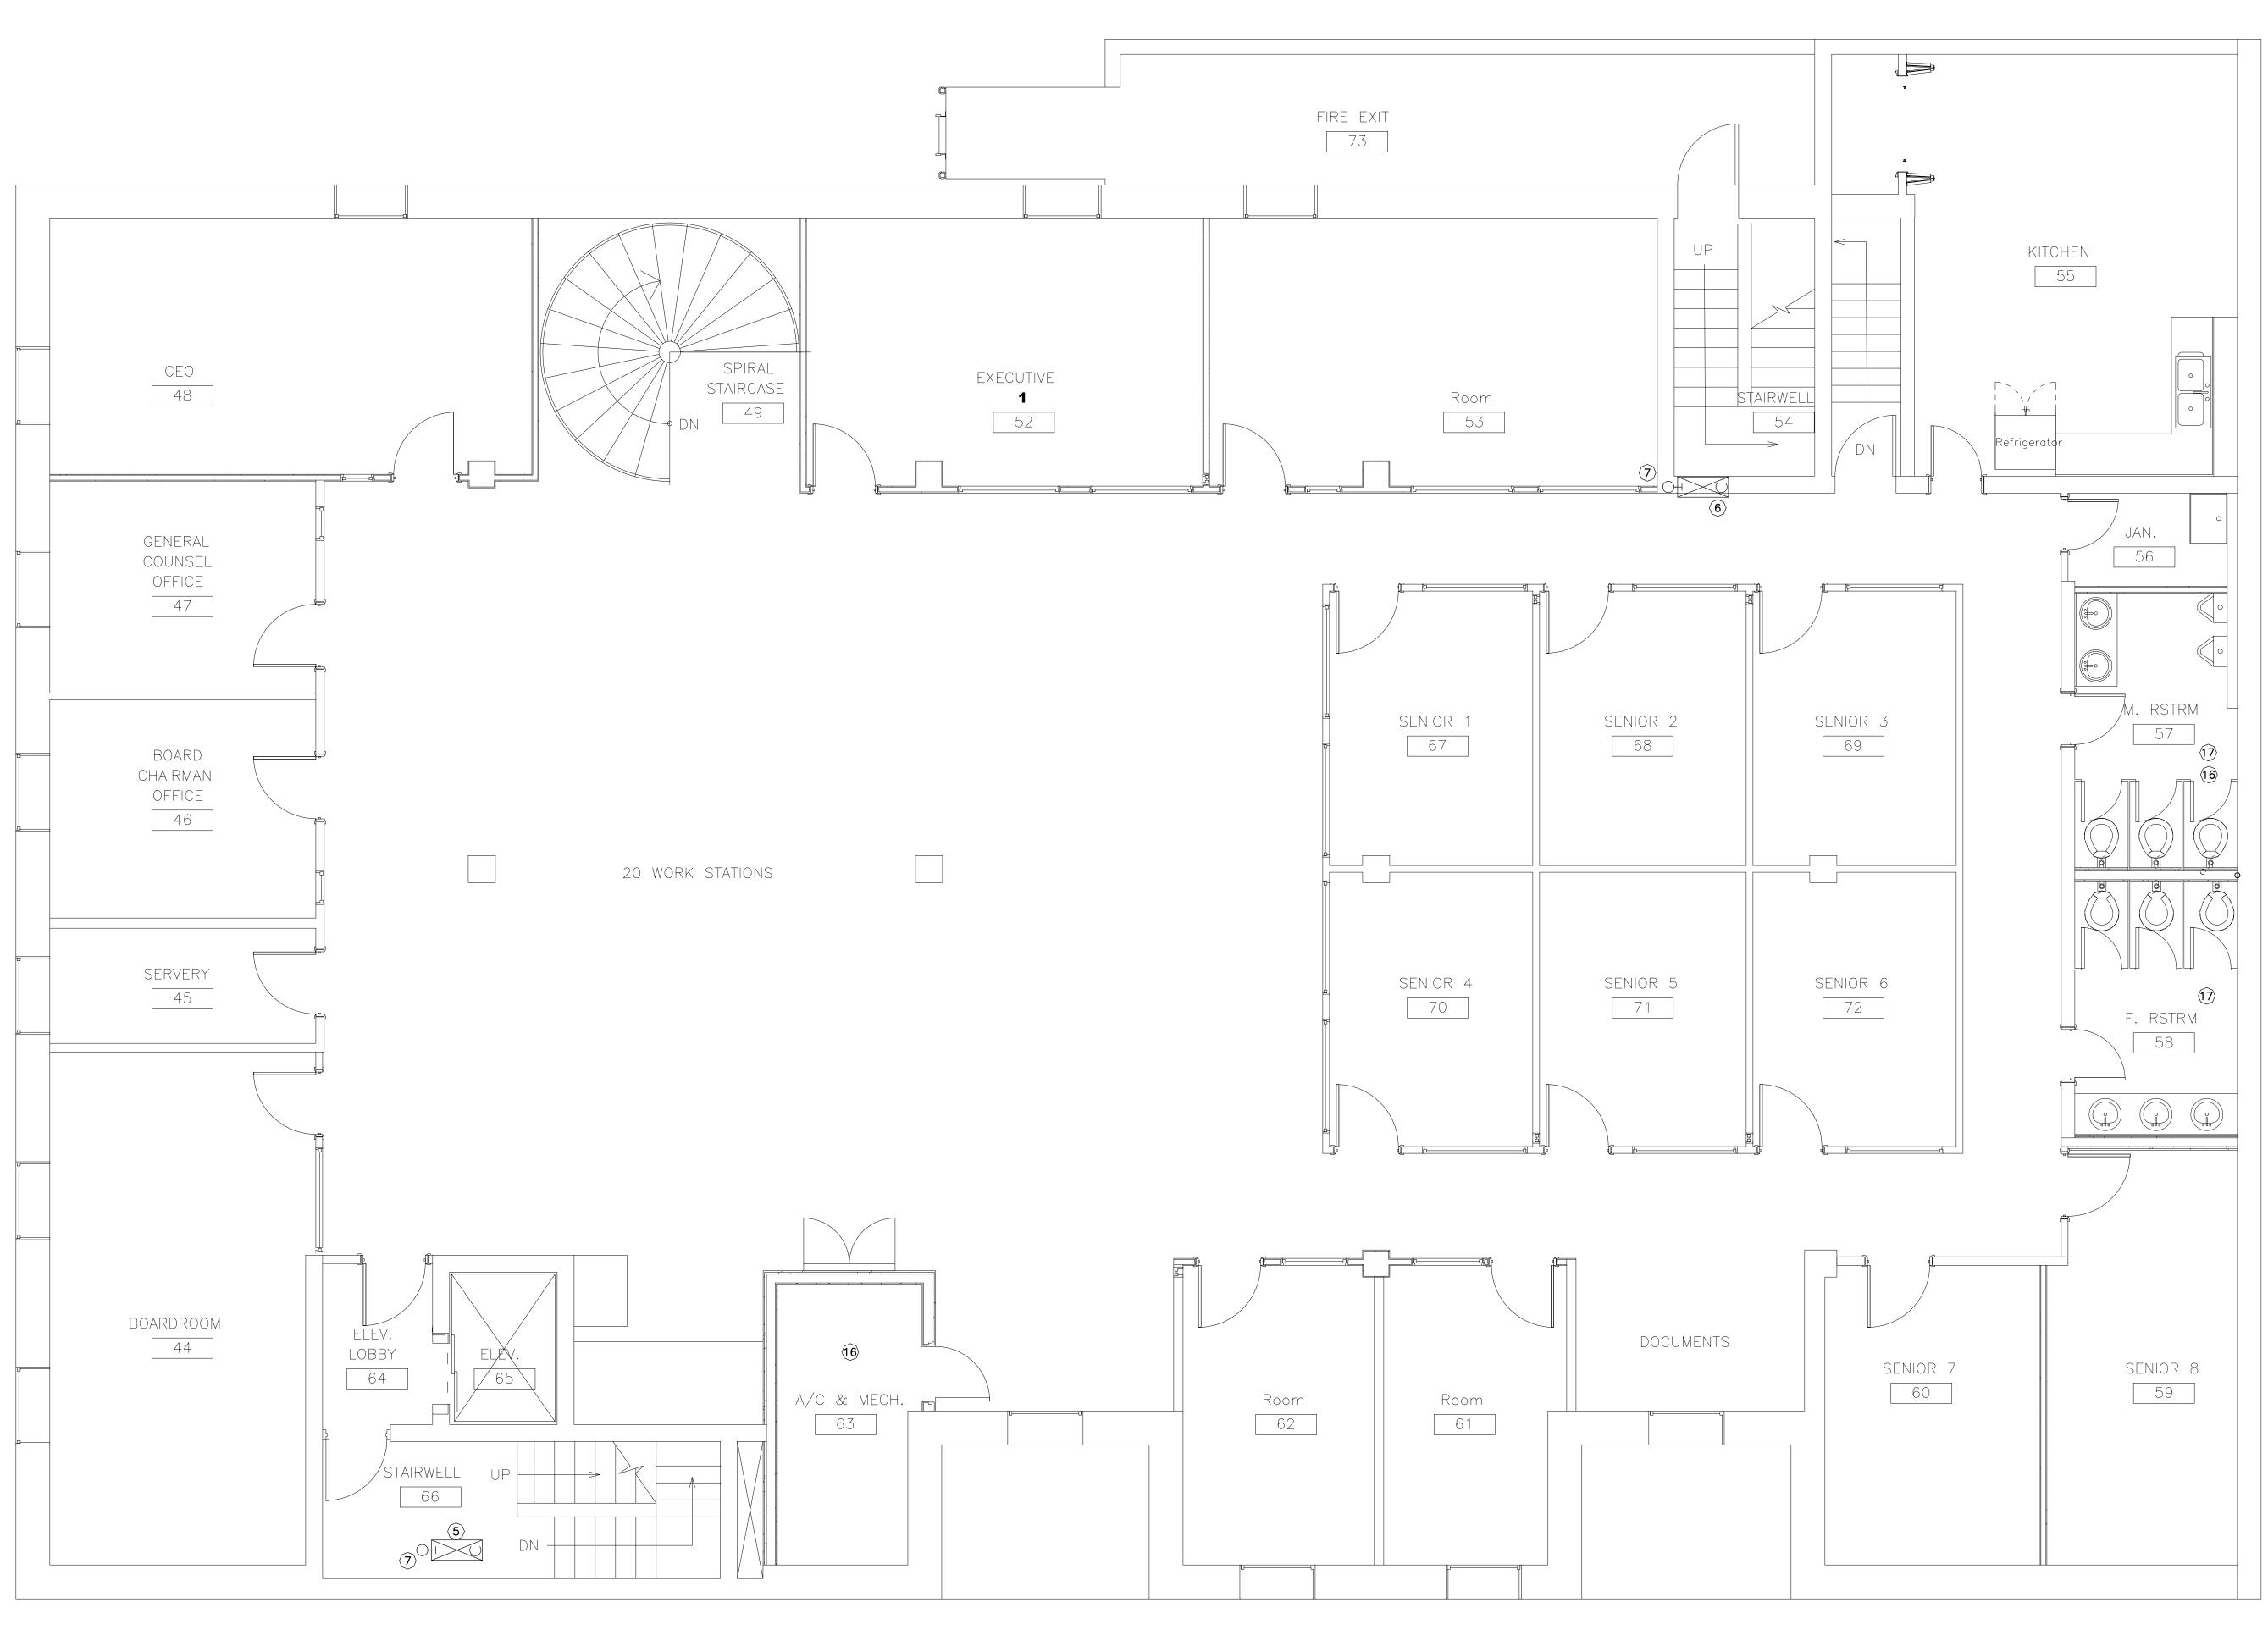



DEMOLITION SCOPE

MECHANICAL:


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A III III Engineers a	& Consultant	rs, Limited		
PROJECT PROPOSED UTILITIES RE AUTHORITY	EGULATION	& COMPETIT	ION	
		SSAU, BAHAMAS		
TITLESSECONDFLOORDEMOLITIONSCALE $1/4" = 1'-0"$ CLIENTURCA				
project architect TDG Drawn by B&A	NUMBER PROJECT	drawing no. $D-4$		



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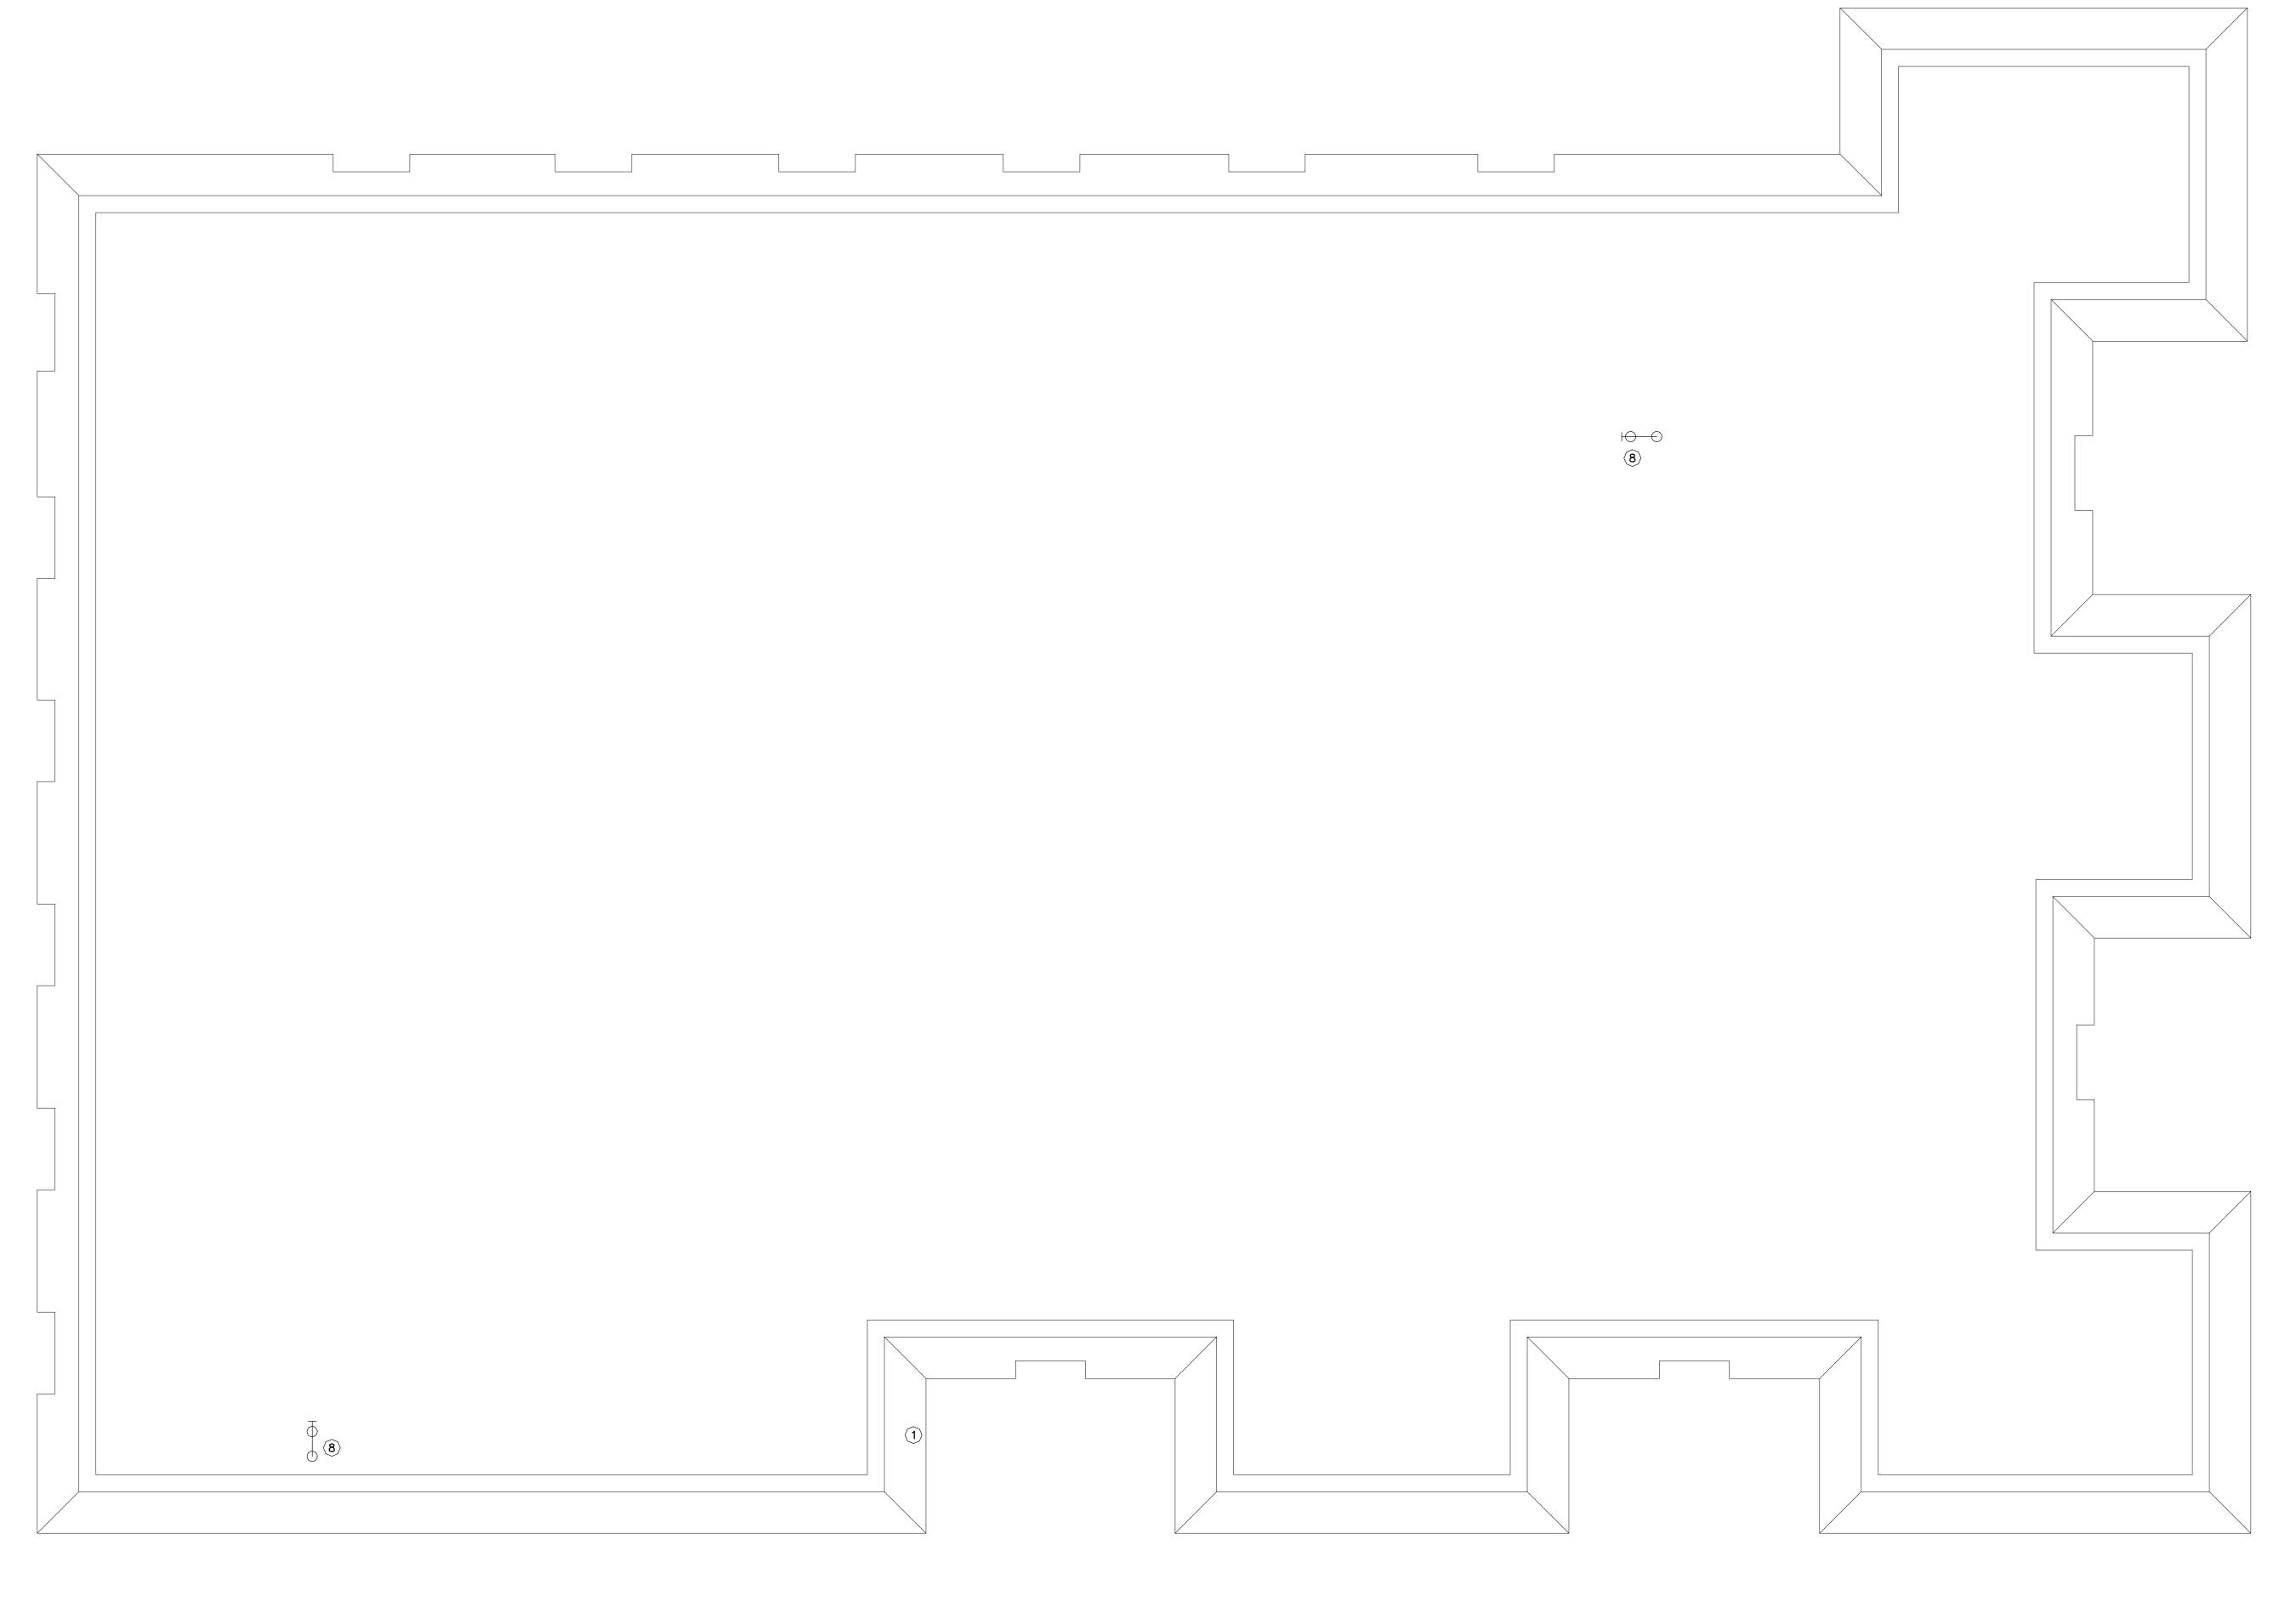
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/30/23 DESIGN DEVELOPM 10. date revision	
BROWN & AS Engineers & Consultants,	SOCIATES
PROPOSED RENOVATIONS	
PROPOSED RENOVATIONS UTILITIES REGULATION & AUTHORITY – FREDERICH	
PROPOSED RENOVATIONS UTILITIES REGULATION & AUTHORITY – FREDERICH OCATION FREDERICK STREET, NASS	
PROPOSED RENOVATIONS UTILITIES REGULATION & AUTHORITY – FREDERICH OCATION FREDERICK STREET, NASS	
PROPOSED RENOVATIONS UTILITIES REGULATION & AUTHORITY - FREDERICH FREDERICK STREET, NASS TITLES THIRD FLOOR DEMOLIT SCALE 1/4" = 1'-0"	



ROOF DEMOLITION PLAN SCALE: 1/4" = 1'-0"
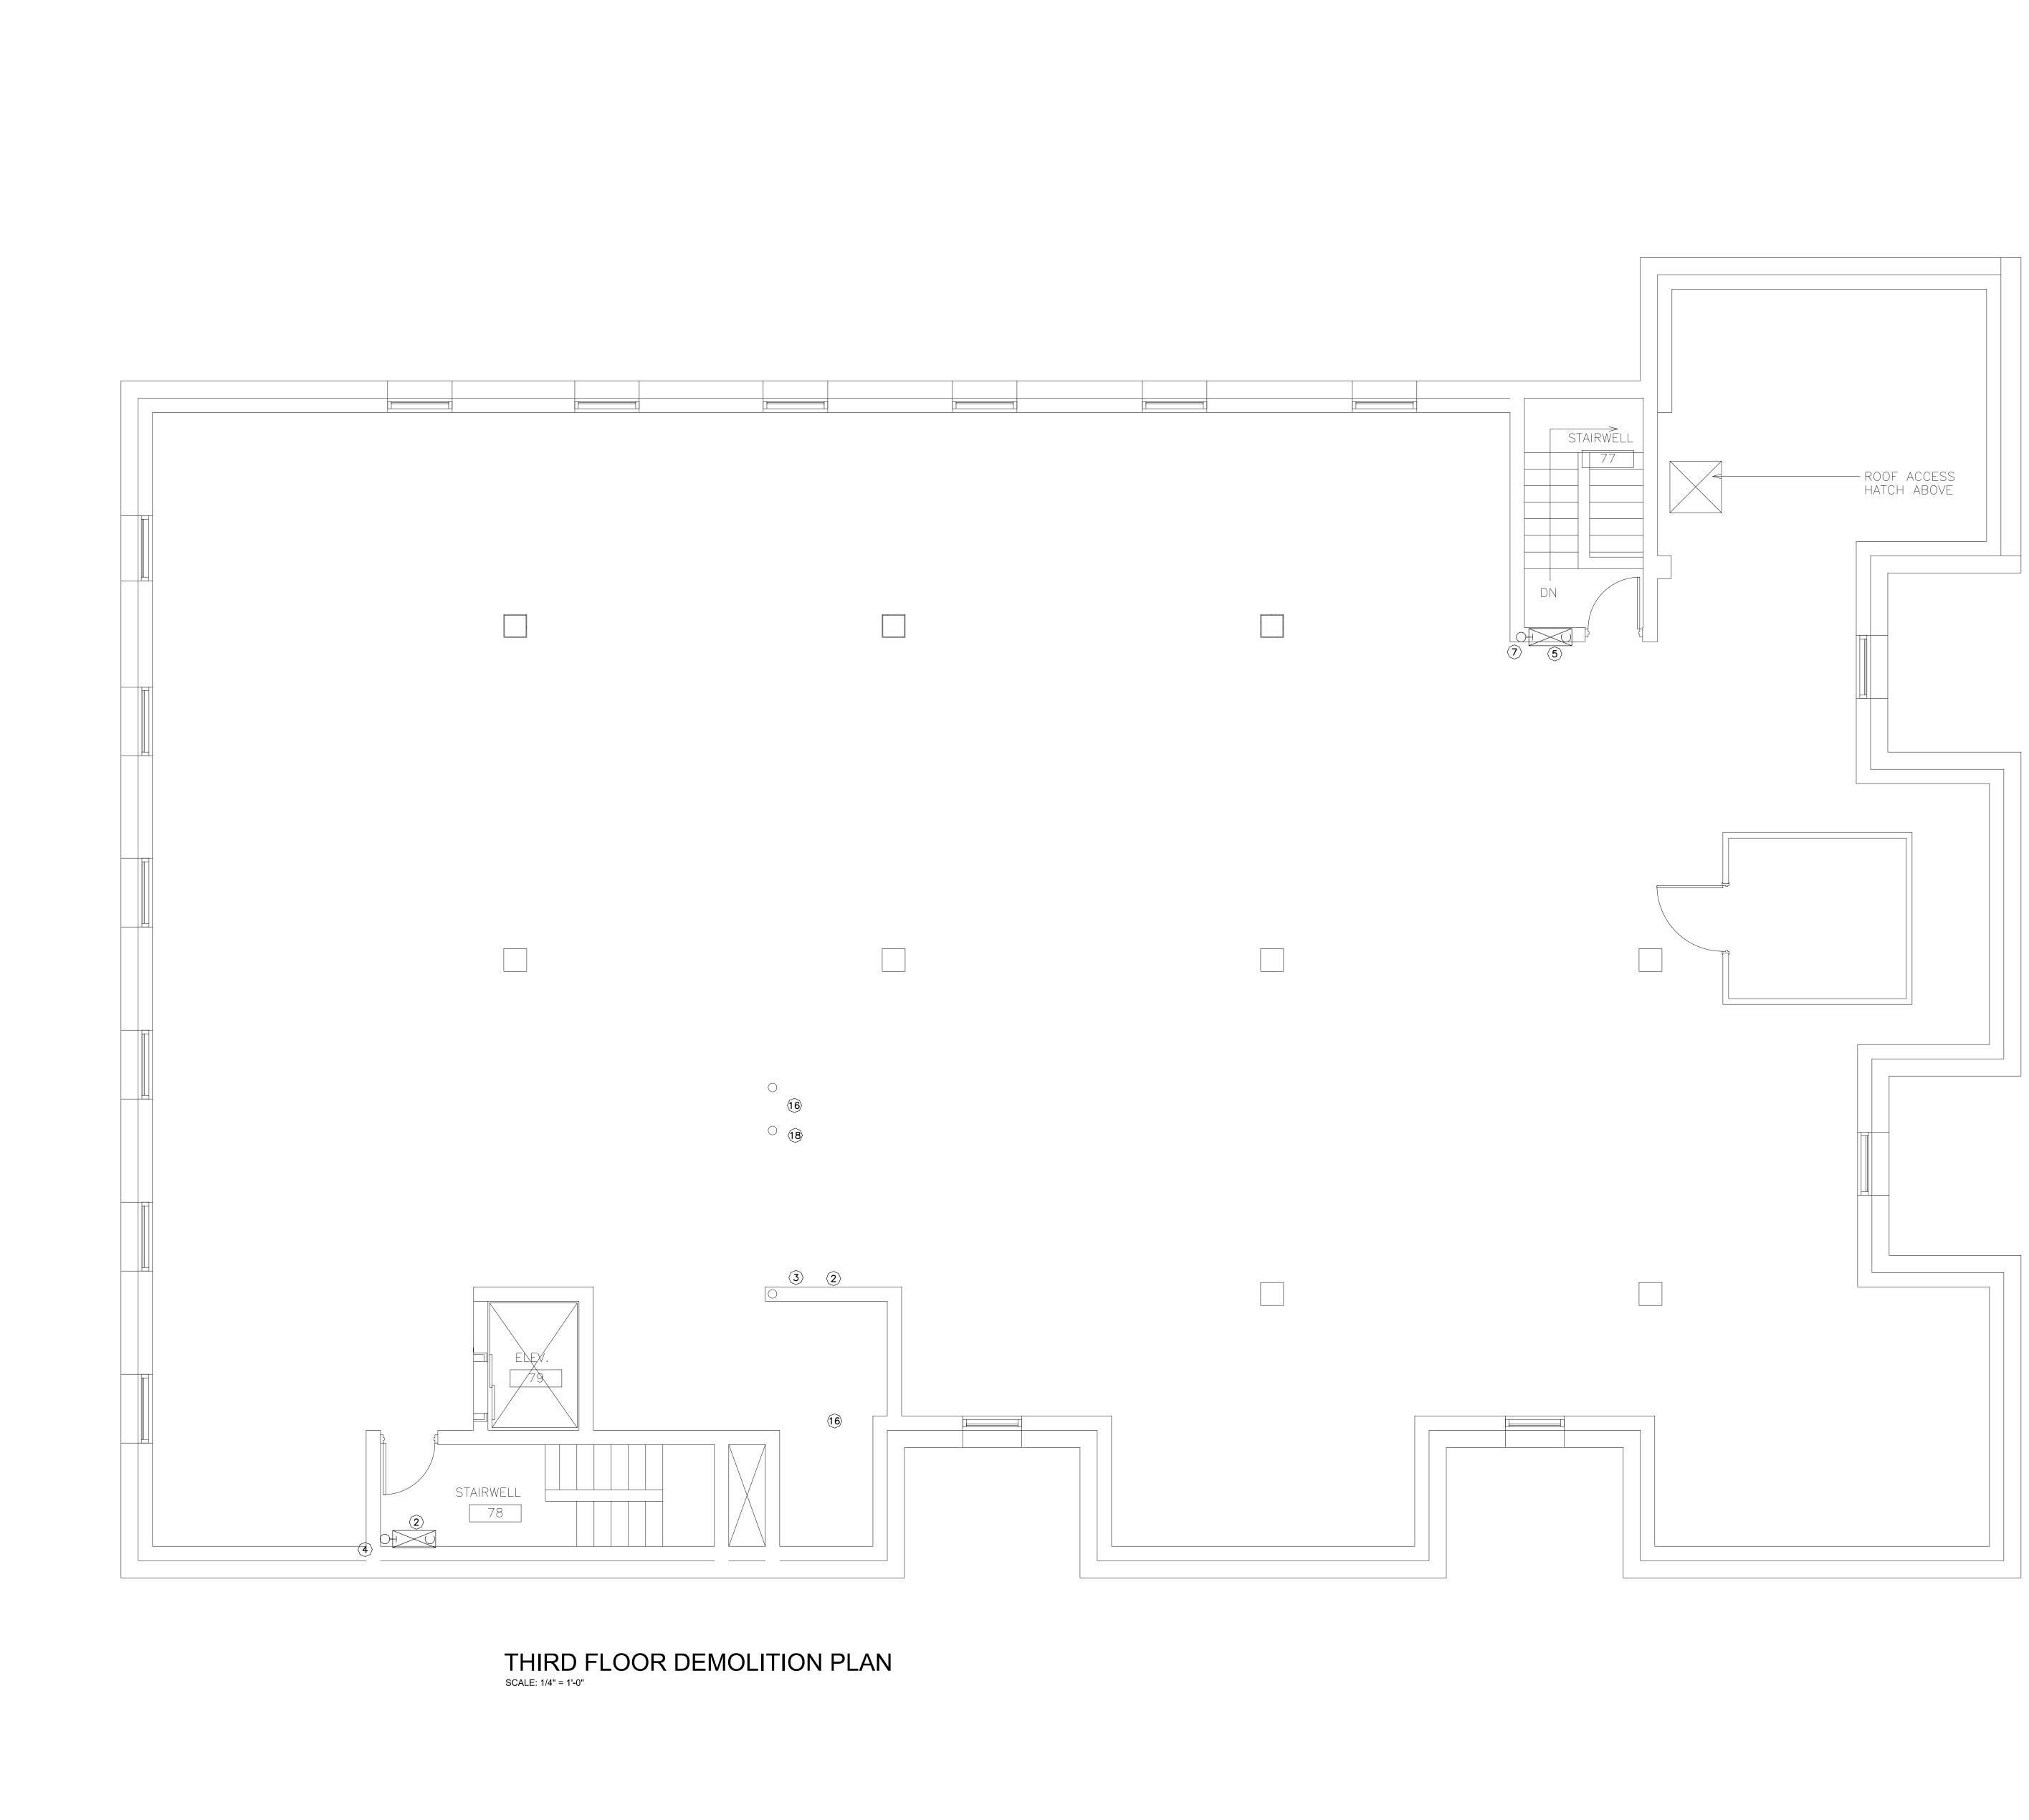
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PROJECT PROPOSED RENOVATIONS FOR UTILITIES REGULATION & COMPETITION AUTHORITY – FREDERICK HOUSE			
LOCATION FREDERICK STREET, NASSAU, BAHAMAS.			
TITLES ROOF DEMOLITION SCALE $1/4" = 1'-0"$ CLIENT URCA			
PROJECT ARCHITECT NUMBER TDG	DRAWING NO.		
DRAWN BY B&A DATE OCT.'12	D-6 Ref. \URCA		